E-8

DATE: <u>DEC. 2005</u> SCALE: <u>1"=20'</u>

FILE NO.: 3232

Cijoriba Groupp, Inc.

CONSULTING ENGINEERS
5507 North Cumberland Avenue, Sulte 402 Chicago, Illnois 60656
Tel. 773.775.4008 Fex 773.775.4014 Email chicago@ciorbe.com


VILLAGE OF MOKENA LAPORTE ROAD REHABILITATION

LAPORTE ROAD IMPROVEMENTS

LIGHTING PLAN

STATION 47+25 TO 53+25

DESIGN: <u>KDM</u>
DRAWN: <u>KDM</u>
CHECKED: <u>JMV</u>

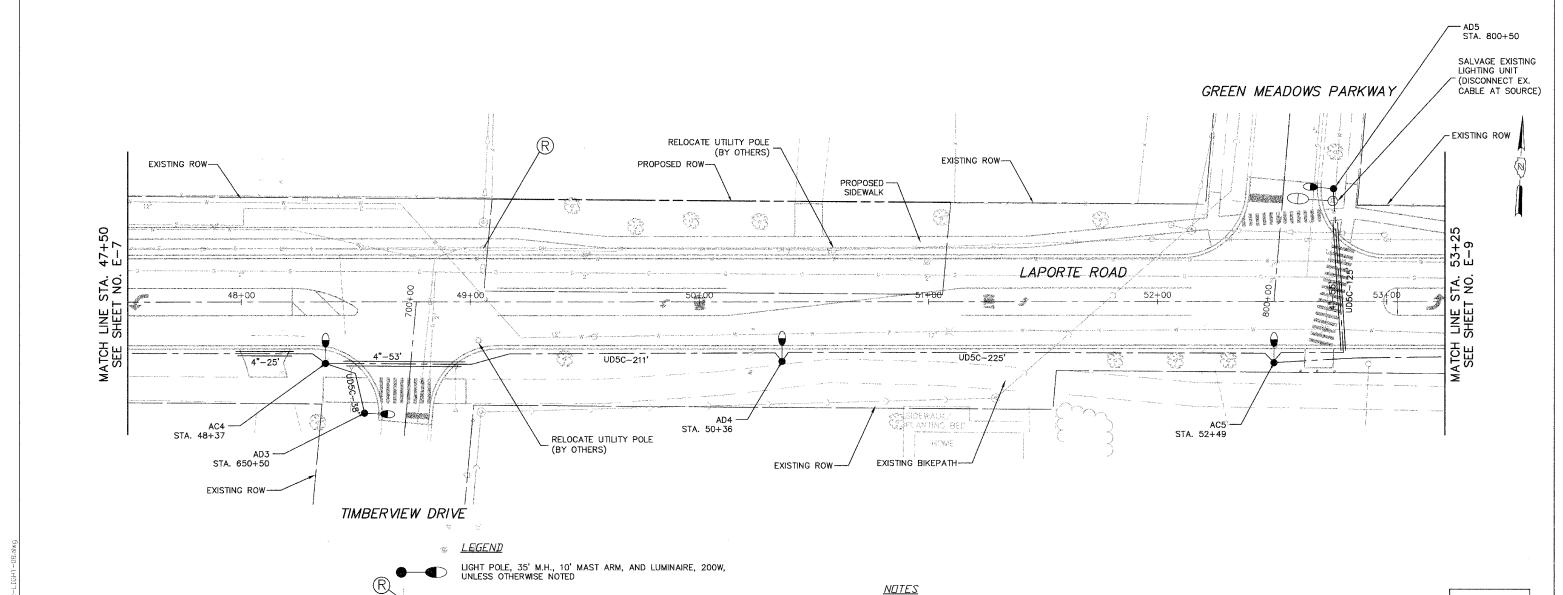

1. ALL POLES SHALL BE OFFSET 8' FROM EDGE OF PAVEMENT TO CENTER OF POLE, UNLESS OTHERWISE NOTED.

2. EXISTING UTILITY POLE MOUNTED LUMINAIRES SHALL REMAIN IN USE DURING CONSTRUCTION.

UTILITY POLE MOUNTED MAST ARM, LUMINAIRE TO BE REMOVED BY OTHERS

UNIT DUCT WITH 4-1/C NO. 4 AND 1/C NO. 6 GROUND 600V (EPR-TYPE RHW) 1-1/2" POLYTHYLENE AND LENGTH AS NOTED

EXISTING LIGHT POLE, SIZE AS NOTED

OFFSET FOUNDATION

GALVANIZED STEEL CONDUIT, PUSHED, DIAMETER AND LENGTH AS NOTED

PROPOSED SERVICE CONNECTION

PROPOSED LIGHTING CONTROLLER, 120/240V, 100A

TEN BAIL? Dec 22, 2005 - Subpm